

Larry H. Will, P.E.

Broadcast Engineering

1055 Powderhorn Drive
Glen Mills, PA 19342-9504

PH (610) 399-1826
FAX (610) 399-0995
E-Mail lwill@voicenet.com

**VIRGINIA BEACH EDUCATIONAL BROADCASTING
FOUNDATION**

LICENSEE OF WJLZ(FM)

CHANNEL 203

VIRGINIA BEACH, VIRGINIA

FAC ID# 69636

FCC FILE # BPED-20030-602BIB

**EXHIBIT 9 OF FORM 302-FM IN SUPPORT OF AN
APPLICATION FOR A COVERING LICENSE**

SPECIAL CONDITIONS 2 THROUGH 5

March 9, 2005

VIRGINIA BEACH EDUCATIONAL BROADCASTING FOUNDATION

LICENSEE OF WJLZ(FM) CHANNEL 203

VIRGINIA BEACH, VIRGINIA

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EXHIBIT 9

SPECIAL CONDITIONS 2 AND 5 – ANTENNA PATTERN CERTIFICATION

WJLZ(FM) was licensed with a previously certified 6 bay elevation one wavelength spaced directional antenna manufactured by SWR, Incorporated and designated as their model FMEC/6-DA. At the new transmitter site proposed in BPED-20030602BIB, due to limitations on available supporting structure, only 2 of the 6 **full wave spaced identical bays** designated by SWR as their model FMEC/2-DA were employed. The previously tested horizontal, vertical, and composite patterns were previously tested by SWR on 06 May 1998 and the test data was submitted to the FCC with the covering License application at approximately that time.

SWR, Incorporated has provided data on the revised FMEC/2-DA to show the reduction in elevation gain of the 2 bay antenna. The 6 bay elevation gain was 6.6058 x (total polarization) or 3.302x for horizontal or vertical polarization. The 2 bay elevation gain, as shown in Figure 4 and Table 4 of this Exhibit is 1.918x total or 0.959x for horizontal polarization. This results in a total composite azimuth and elevation pattern antenna gain of 2.578x or 4.11 db as compared to the original 6 bay gain of 6.8x or 8.3 dB. The composite gain of 2.578x was used in Exhibit 7 to calculate the required T.P.O.

The original SWR factory test methods and results along with the unchanged azimuth data and the revised elevation gain data are attached hereto.

SPECIAL CONDITION 3 – SURVEYORS REPORT




SITE PLANNING • SURVEYING • ENGINEERING

Surveyor's Declaration

I, Scott A. Smith, PE, LS, do declare the following:

1. That I am a licensed surveyor in the Commonwealth of Virginia,
2. I have provided professional services to the Virginia Beach Educational Broadcasting Foundation, Inc., permittee of WJLZ-FM, Virginia Beach, Virginia.
3. That I certify that the WJLZ-FM directional antenna has been orientated at the proper azimuth as authorized in the Construction Permit FCC File Number BPED-20030602BIB.

Date: 1 (month) 24 (day) 2005 (year).

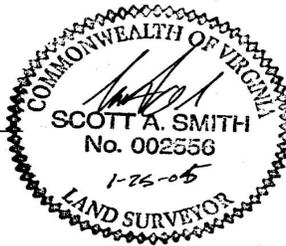


820 Greenbrier Circle, Suite 12 • Chesapeake, Virginia 23320 • Phone (757) 424-5833 • Fax: (757) 424-5835
www.huntclubconsulting.com


SPECIAL CONDITION 4 – ANTENNA INSTALLATION

The SWR, Incorporated Model FMEC/2-DA antenna was installed as specified in the installation instructions submitted with the antenna and was supervised by Mr. William Verebely, President of WJLZ(FM). Mr. Verebely has the technical qualifications to assemble and install the antenna per the supplied instructions and utilized the services of the Licensed Surveyor to insure correct orientation.

Exhibit 9 was prepared by Larry H. Will, P.E. with data supplied by SWR Engineering.

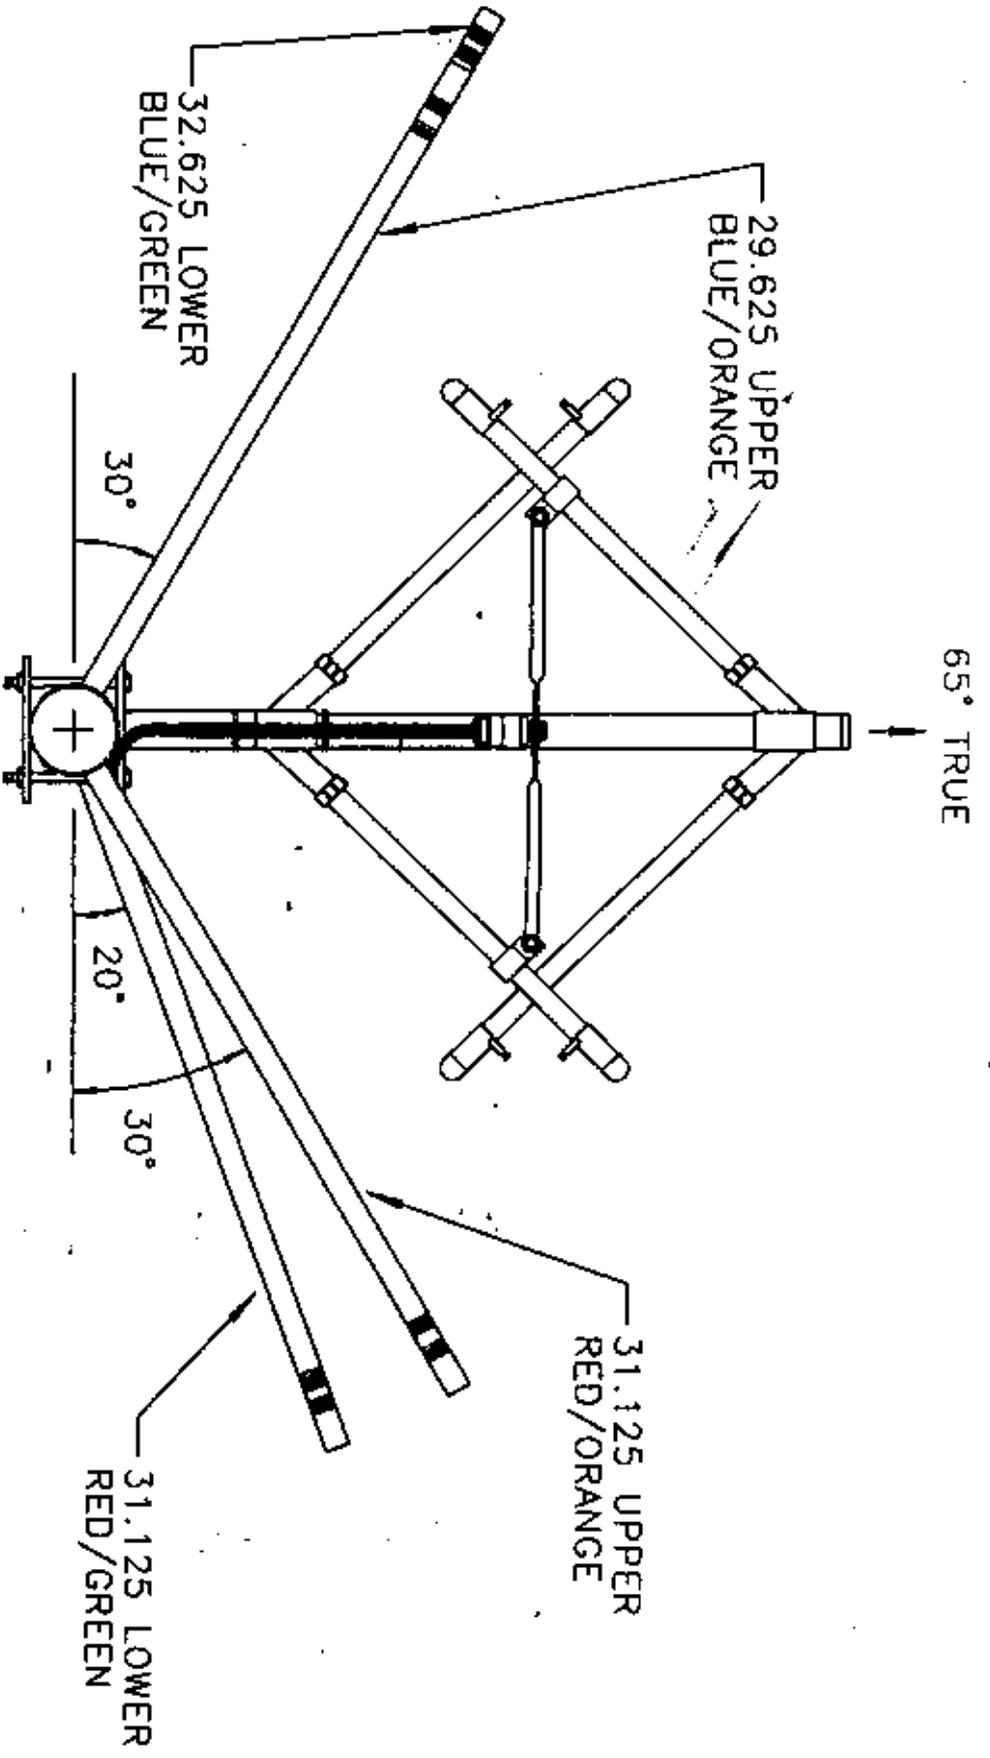

REV. 5/6/98	S.W.R. INC. EBENSBURG, PA. 15931	
TOLERANCES X ± .015 XX ± .005 XXX ± .002	TITLE: FMEC/5-DA 88.5 MHz., WODC, CHESAPEAKE, VIRGINIA ANTENNA/PARASITIC TOP VIEW	
X/X ± 1/32 DEC. ± 1/2	DATE: 5/4/98	SCALE: NTS
UNLESS OTHERWISE SPECIFIED	DRAWN: JRM	SHOP APPROVED: <i>[Signature]</i>
	MATERIAL:	ENGINEER: 0979-A04

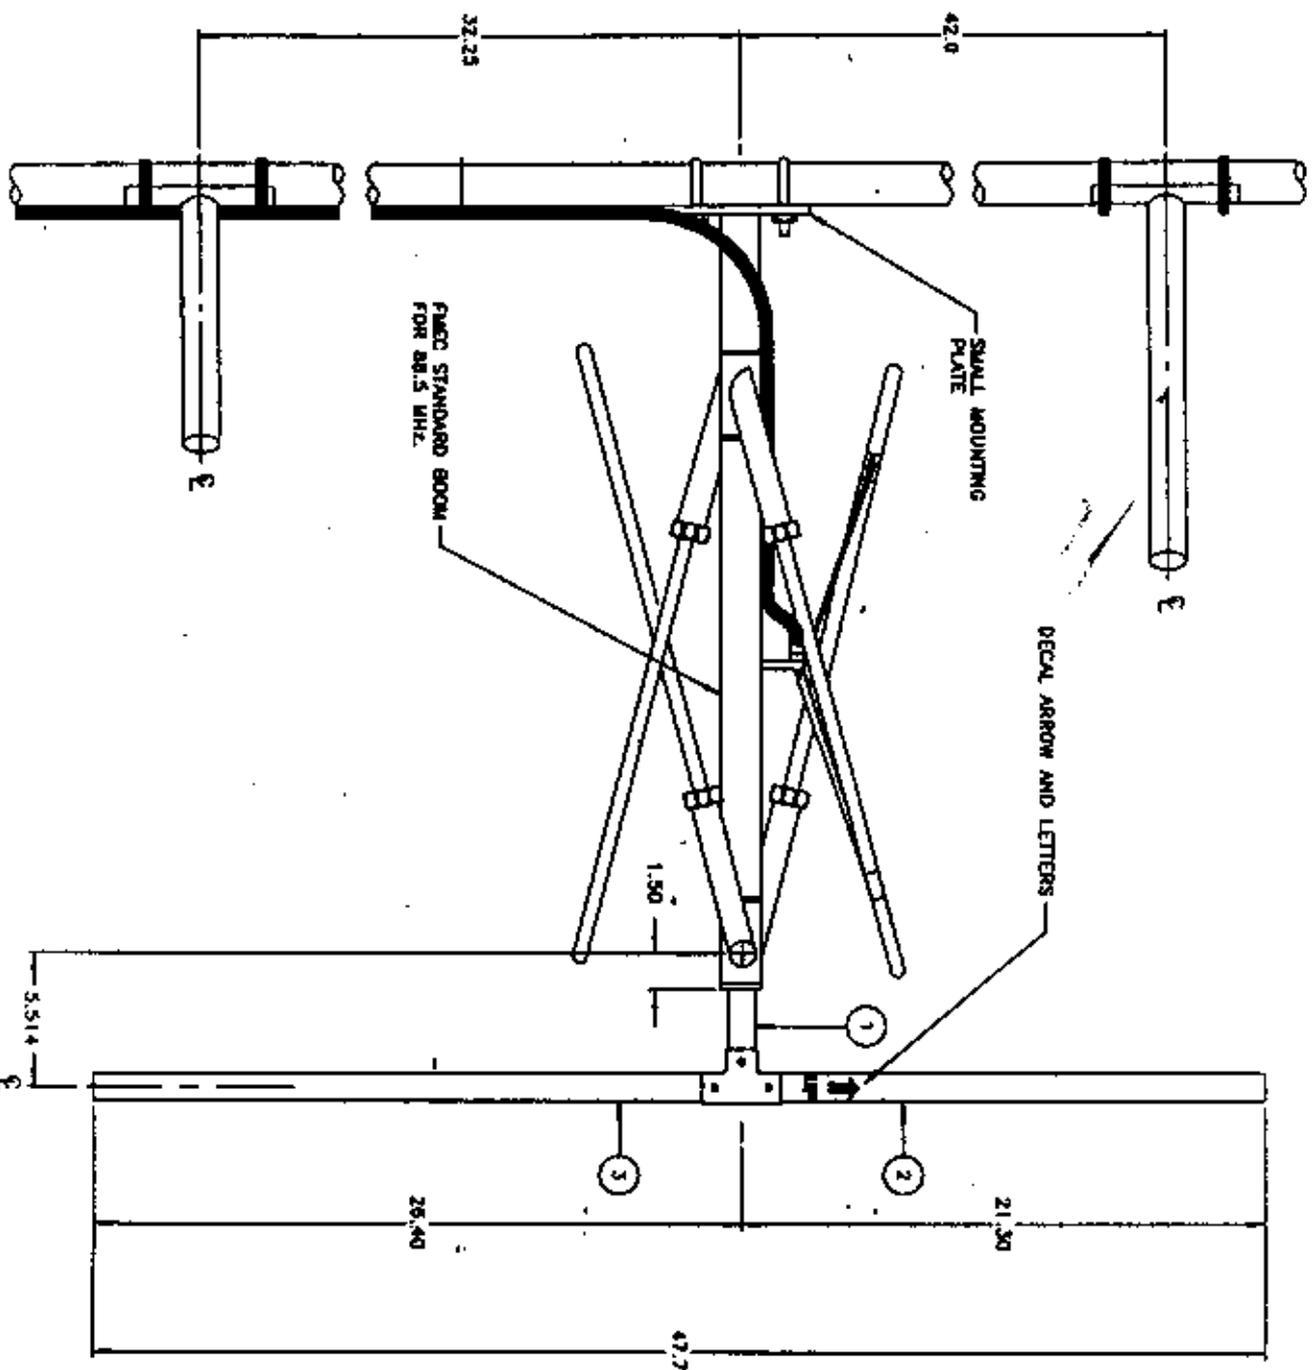

DATE	APPROVED	BY

REV	DESCRIPTION	DATE	BY
1	ISSUED FOR FAB	5/21/68	JWS
2	REVISED TO ADD DIMENSIONS	5/21/68	JWS
3	REVISED TO ADD DIMENSIONS	5/21/68	JWS
4	REVISED TO ADD DIMENSIONS	5/21/68	JWS
5	REVISED TO ADD DIMENSIONS	5/21/68	JWS
6	REVISED TO ADD DIMENSIONS	5/21/68	JWS
7	REVISED TO ADD DIMENSIONS	5/21/68	JWS
8	REVISED TO ADD DIMENSIONS	5/21/68	JWS
9	REVISED TO ADD DIMENSIONS	5/21/68	JWS
10	REVISED TO ADD DIMENSIONS	5/21/68	JWS

S.F.E. INC.
 1000 W. 11th St.
 Phoenix, AZ 85001

78127-6-04
 BULL'S HEAD, MODEL, CHECKING, VERTICAL
 TYPICAL, BMT, SIDE VIEW

5/21/68
 JWS
 JWS

08373-02